

S1B-0090

PROFILE VIEW

EL. 1153'


4+00

GEOTECH HDD-03

-NG EL. 1232' -CL (0.0' - 7.5') -SILTY CLAY (7.5' - 11.0') -SM (11.0' - 19.0') -SILT STONE (19.0' - 23.3')

COMPLETION DEPTH EL. 1210'

OTE: REFER TO TEST BORING LOG <u>HDD-03</u> DR COMPLETE SOIL MATERIAL DESCRIPTIO

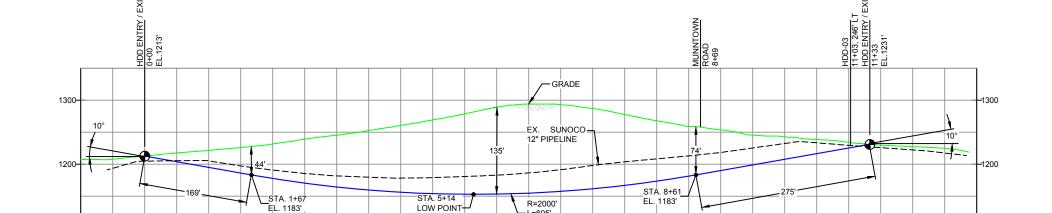

L=695'

S=698'

6+00

0+00

1100

2+00

- DESIGN AND CONSTRUCTION:

 1. CONTRACTOR SHALL FIELD VERIFY DEPTH OF ALL EXITING UTILITIES SHOWN OR NOT SHOWN ON THIS DRAWING.

 2. THE MINIMUM SEPARATION DISTANCE FROM EXISTING SUBSURFACE UTILITIES SHALL NOT BE LESS THAN 10 FEET AS MEASURED FROM THE OUTSIDE EDGE OF THE UTILITY TO OUTSIDE OF PROPOSED PIPELINE.

 3. DESIGNED IN ACCORDANCE WITH CFR 49 195 & ASME B31.4

 4. CROSSING PIPE SPECIFICATION:
 HDD HORZ, LENGTH (L=):
 HDD PIPE LENGTH (S=): 1142
 20°x 0.456° W.T., X-65, APISL, PSL2, ERW, BFW
 COATING: 14-16 MILS FBE WITH 30-35 MIL ARO (POWERCRETE R95)

1+00

- INTERNAL DESIGN PRESSURE 1480 PSIG (SEAM FACTOR 1.0, DESIGH FACTOR 0.50).
 INSTALLATION METHOD: HORIZONTAL DIRECTIONAL DRILL (HDD).
 PIPIELINE WARNING MARKERS SHALL BE INSTALLED ON BOTH SIDES OF ALL ROAD, RAILWAY, AND STREAM GROSSINGS.
 CARRIER PIPE NOT ENCASED.
 PIPE / AMBIENT TEMPERATURE MUST BE NO LESS THAN 30°F DURING PULLBACK WITHOUT PRIOR WRITTEN APPROVAL FROM THE ENGINEER.
 CONDUCT 4-HOUR PRE-INSTALLATION HYDROTEST OF HDD PIPE STRING TO MINIMUM 1850 PSIG.
 SEE SUNOCO PENNSYLVANIA PIPELINE PROJECT ESRI WEBMAP FOR ACCESS ROAD ALIGNMENT.

8+00

- SUNOCO PIPELINE, L.P.'S HORIZONTAL DIRECTIONAL DRILL INADVERTENT RETURN CONTINGENCY PLAN WILL BE IMPLEMENTED AT ALL TIMES.
 SUNOCO PIPELINE, L.P.'S EROSION AND SEDIMENTATION CONTROL PLAN WILL BE IMPLEMENTED AT ALL TIMES.

1100 13+00

12+00

				COATING: 14-16 MILS FE		1 30-35 MIL ARO (POWERCRETE R95)						
NOTES		REF. DR	AWING	REVISIONS								
1. ALL COORDINATES SHOWN ARE IN LATITUDE AND LONGITUDE. ALL MSL ELEVATIONS ARE NAD83 2. STATIONING IS BASED ON HORIZONTAL DISTANCES. 3. ROONEY ENGINEERING, INC. AND SUNOCO PIPELINE, LP ARE NOT RESPONSIBLE FOR LOCATION OF FOREIGN LITLIES SHOWN IN PLOT PLAN OR PROFILE. THE INFORMATION SHOWN HEREON IS FURNISHED WITHOUT LIABILITY ON THE PART OF ROONEY ENGINEERING, INC. AND SUNOCO PIPELINE, LP, FOR ANY DAMAGES RESULTING FROM ERRORS OR OMISSIONS THEREIN. 4. CONTRACTOR IS RESPONSIBLE FOR LOCATINGS ALL UTILITIES. CONTACT ONE CALL AT 811 PRIOR TO DIGGING. 5. SUNOCO EMERGENCY HOTLINE NUMBER IS #1-800-788-7440.	ES-1.35	то	ES-1.36	EROSION & SEDIMENT PLAN								
	SHEET 22	то	SHEET 22	AERIAL SITE PLAN			П					
		П										
		П										-
					EP1	REVISED PER PADEP COMMENTS	MRS	05/06/16	RMB (05/06/16	AAW /	05/06/16
		П			EP		JTW	03/15/16	RMB (03/15/16	AAW /	03/15/16
	DWG NO		DWG NO	DESCRIPTION	NO.	DESCRIPTION	BY	DATE	CHK	DATE	APP	DATE



11+00

10+00

TETRA TECH ROONEY (303) 792-5911

SUNOCO PIPELINE, L.P.
0-INCH HORIZONTAL DIRECTIONAL DRILL

MUNNTOWN ROAD PENNSYLVANIA PIPELINE PROJECT

SCALE: 1"=150' DWG. NO: PA-WA-0119.0003-RD