

## HDD PA-LE-0005.0000-RD (S-A49)

Given the design, the threat of inadvertent return has been reduced to the maximum extent practicable and in this case that threat is considered to be low. Implementing this design, along with adherence to the Pennsylvania Pipeline Project Inadvertent Return Contingency Plan will ensure inadvertent impacts, if they were to occur, are also minimized to the maximum extent.


The drill crosses under Stream A49 (S-A49) three times between the entry and exit locations. Only the western and eastern edges of the stream crossing are considered here. The drill will enter/exit 1,100 feet from the western edge of S-A49 and enter/exit 50 feet from the eastern edge. The drill will pass 50 feet below the western edge and 20 feet below the eastern edge of S-A49. Due to a design change geotechnical bores were not completed for this horizontal directional drill. However, it is adjacent to PA-LE-0001.0000 and it can be assumed the soil layers are the same, clays and silty sands. Based on the drill profile and the adjacent geotechnical report minimal inadvertent returns are expected.

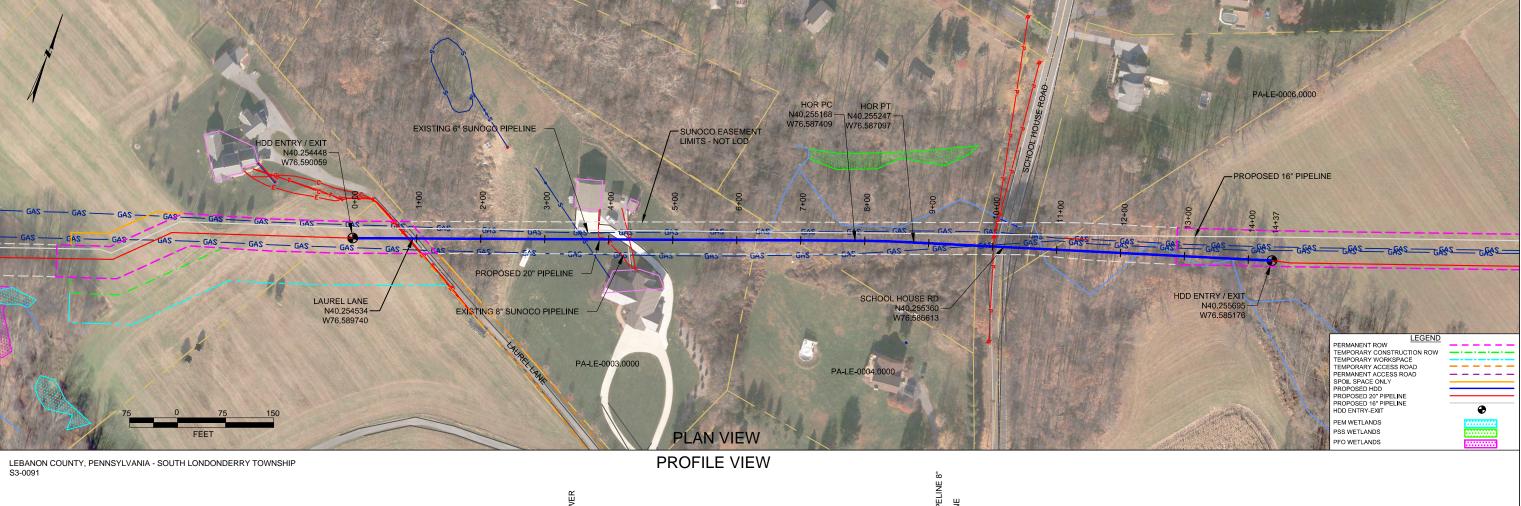


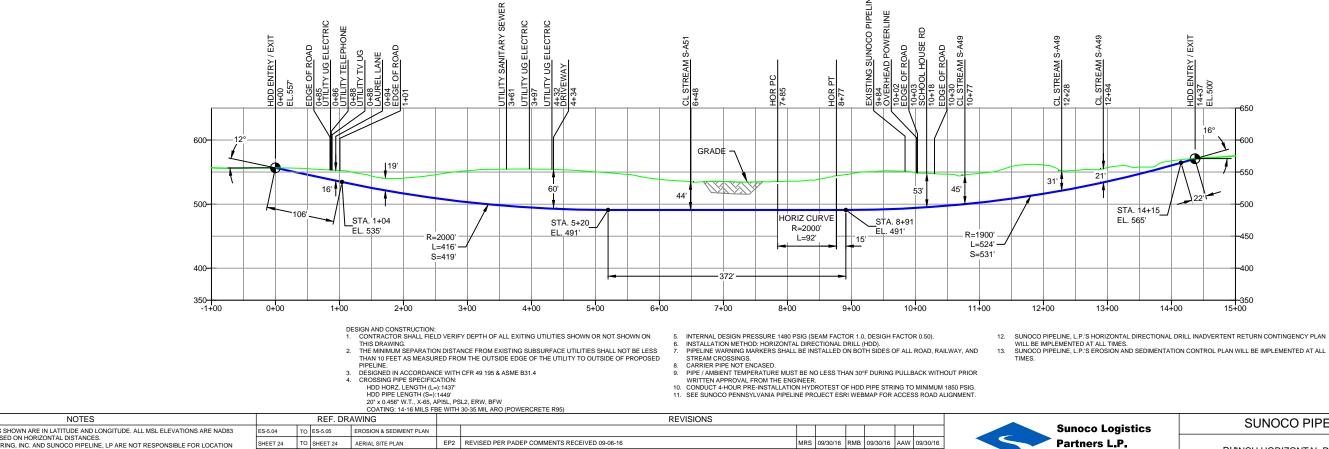

 ALL COORDINATES SHOWN ARE IN LATTUDE AND LONGITUDE. ALL MSL ELEVATIONS ARE NAD83
 STATIONING IS BASED ON HORIZONTAL DISTANCES.
 ROONEY ENGINEERING, INC. AND SUNOCO PIPELINE, LP ARE NOT RESPONSIBLE FOR LOCATION
 OF FOREIGN UTILITIES SHOWN IN PLOT PLAN OR PROFILE. THE INFORMATION SHOWN HEREON IS
 FURNISHED WITHOUT LIABILITY ON THE PART OF ROONEY ENGINEERING, INC. AND SUNOCO PIPELINE,
 LP, FOR ANY DAMAGES RESULTING FROM ERRORS OR OMISSIONS THEREIN.
 4. CONTRACTOR IS RESPONSIBLE FOR LOCATING ALL UTILITIES. CONTACT ONE CALL AT 811 PRIOR TO
 DYDGING EP1 REVISED PER PADEP COMMENTS DLM 05/10/16 RMB 05/10/16 AAW 05/10/16 EP MRS 03/15/16 RMB 03/15/16 AAW 03/15/16 MRS 02/18/16 RMB 02/18/16 AAW 02/18/16 TETRA T 1 DESIGN CHANGE DIGGING. 5. SUNOCO EMERGENCY HOTLINE NUMBER IS #1-800-786-7440. 0 ISSUED FOR CONSTRUCTION MRS 01/21/16 RMB 01/21/16 AAW 01/21/16 (303) 792-DWG NO DWG NO DESCRIPTION NO. DESCRIPTION BY DATE CHK DATE APP DATE

noco Logistics	SUNOCO PIPELINE, L.P.										
rtners L.P.		DIANCH HORIZONTAL DIRECTIONAL DRILL SCHOOL HOUSE RD									
ECH ROONEY		PENNS	YLVANIA PIPELINE PROJECT								
-5911	SCALE:	1"=150'	DWG. NO: PA-LE-0005.0000-RD								

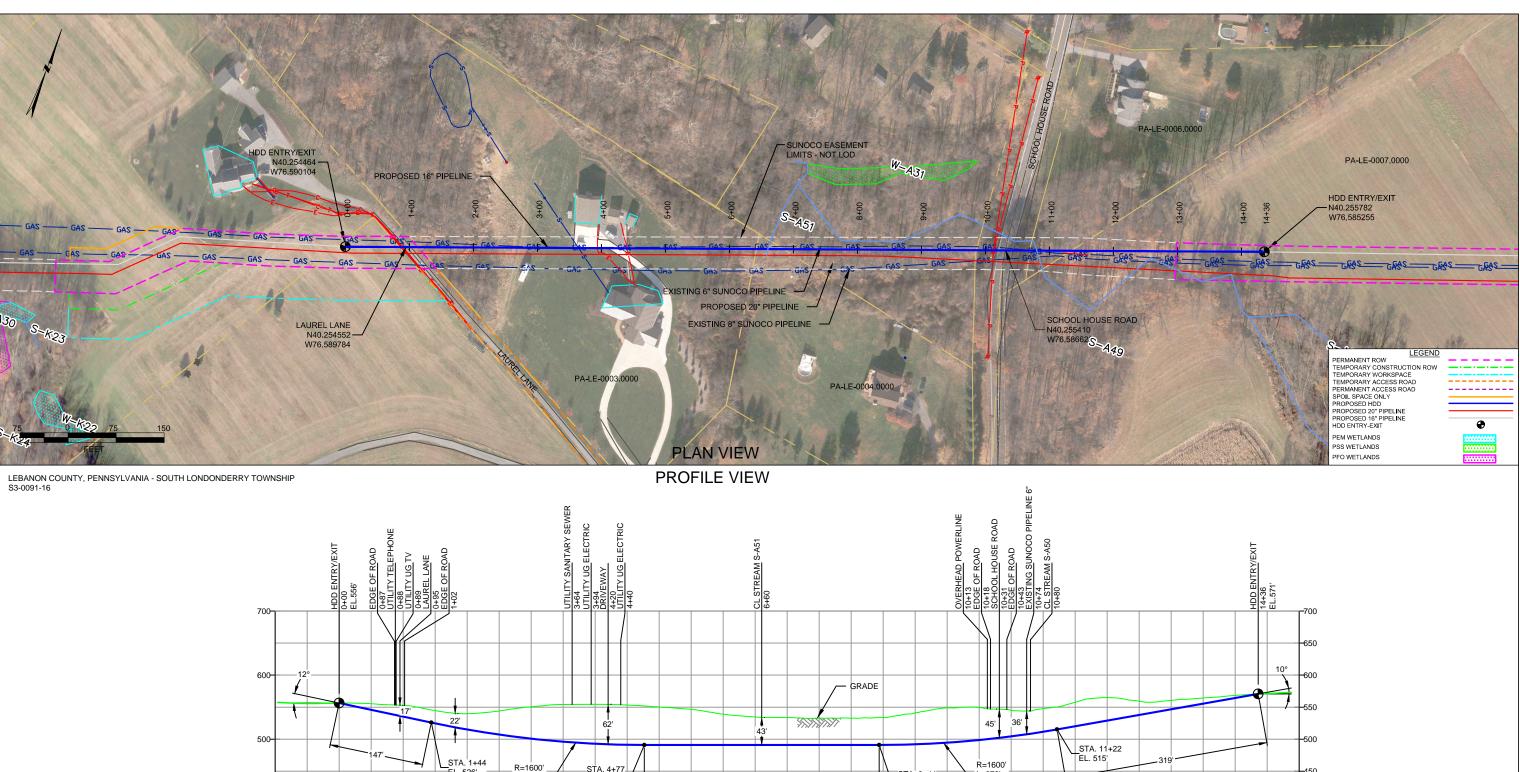

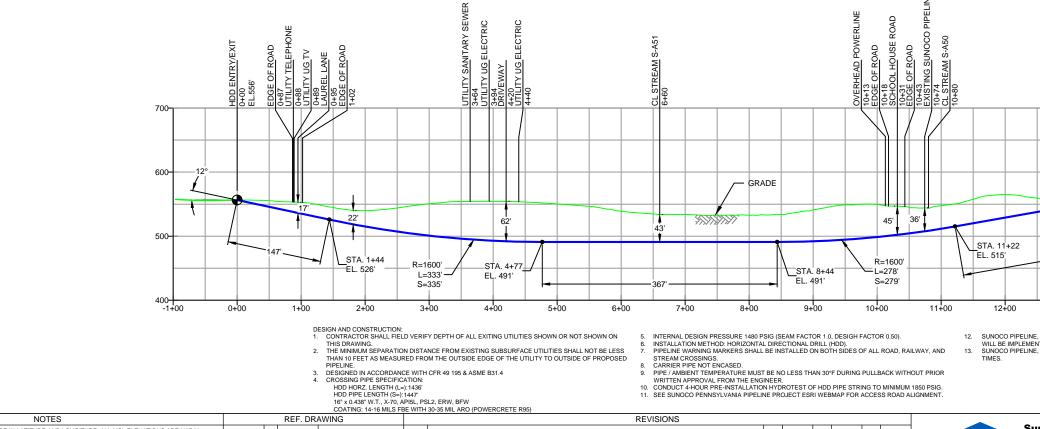

NOTES		REF. DRAWING			AWING	REVISIONS								_		
		ES-5.04	TO ES-5	5.05	EROSION & SEDIMENT PLAN											Sunc
2. STATIONING IS BASED ON HORIZONTAL DISTANCES. 3. ROONEY ENGINEERING, INC. AND SUNDCO PIPELINE, LP ARE NOT RESPONSIBLE FOR LOCATION OF FOREIGN UTILITIES SHOWN IN PLOT PLAN OR PROFILE. THE INFORMATION SHOWN HEREON IS FURNISHED WITHOUT LIABILITY ON THE PART OF ROONEY ENGINEERING, INC. AND SUNDCO PIPELINE, LP, FOR ANY DAMAGES RESULTING FROM ERRORS OR OMISSIONS THEREIN. 4. CONTRACTOR IS RESPONSIBLE FOR LOCATING ALL UTILITIES. CONTACT ONE CALL AT 811 PRIOR TO DIGGING	SHEET 24	TO SHE	ET 24	AERIAL SITE PLAN	EP2	REVISED PER PADEP COMMENTS RECEIVED 09-06-16	MRS	10/07/16	6 RMB	10/07/16	AAW 10	0/07/16			Parti	
					EP1	REVISED PER PADEP COMMENTS	JTW	05/10/16	8 RMB	05/10/16	AAW 05	5/10/16				
					EP		MRS	03/15/16	6 RMB	03/15/16	AAW 03	3/15/16				
					1	DESIGN CHANGE	MRS	02/18/16	RMB	02/18/16	AAW 02	N 02/18/16		L TETRA T		
	5. SUNOCO EMERGENCY HOTLINE NUMBER IS #1-800-786-7440.					0	ISSUED FOR CONSTRUCTION	MRS	01/21/16	8 RMB	01/21/16	AAW 0	1/21/16			
		DWG NO	D	WG NO	DESCRIPTION	NO.	DESCRIPTION	BY	DATE	СНК	DATE	APP	DATE	J	(303)	792-5
																-

SUNOCO PIPELINE, L.P.'S HORIZONTAL DIRECTIONAL DRILL INADVERTENT RETURN CONTINGENCY PLAN WILL BE IMPLEMENTED AT ALL TIMES.
 SUNOCO PIPELINE, L.P.'S EROSION AND SEDIMENTATION CONTROL PLAN WILL BE IMPLEMENTED AT ALL TIMES.

14+00

13+00

400

## PRELIMINARY DESIGN ONLY

SUNOCO PIPELINE, L.P. unoco Logistics artners L.P. 16-INCH HORIZONTAL DIRECTIONAL DRILL SCHOOL HOUSE RD PENNSYLVANIA PIPELINE PROJECT TECH ROONEY -5911 SCALE: 1"=150' DWG. NO: PA-LE-0005.0000-RD-16